





VICINITY MAP N.T.S.

UTILITY NOTES

- (1) FACILITIES (UTILITY LINES) SHALL BE LOCATED AND MARKED PRIOR TO EXCAVATION. CALL 811 FOR DIG ALERT.
- (2) CONTRACTOR SHALL HAND-EXPOSE TO A POINT OF NO CONFLICT 24" ON EITHER SIDE OF THE UNDERGROUND FACILITY, REGARDLESS OF THE ESTIMATED DEPTH.
- (3) DEPTHS SHOWN ARE APPROXIMATE. ESTIMATED DEPTHS ARE FROM THE GROUND SURFACE TO THE CENTER OF THE FACILITY, INVERT OF WASTE LINES, OR TO THE FACILITY TRACER WIRE. DEPTH ESTIMATES SHOULD BE USED WITH CAUTION AND MAY VARY ALONG THE LENGTH OF THE FACILITY.
- 4) THE SCOPE OF THIS SURVEY DOES NOT INCLUDE FACILITY SIZE OR NUMBER OF CONDUIT IN MULTIPLE CONDUIT RUNS. IRRIGATION LINES ARE NOT INCLUDED IN THIS SURVEY.
- (5) THE BACKGROUND SITE PLAN USED IN PREPARING THIS MAP WAS PREPARED BY OTHERS AND PROVIDED TO ULTRA ENGINEERING BY THE CLIENT. ULTRA ENGINEERING MAKES NO REPRESENTATION AS TO THE ACCURACY OF THE PLAN.
- 6 IN THE EVENT THE INFORMATION SHOWN IN THIS PLAN VARIES FROM THE ACTUAL SITE CONDITIONS, ULTRA ENGINEERING SHALL BE NOTIFIED WITHIN 24 HOURS AFTER DISCOVERY OF THE CONFLICT.

ELECTRICAL ————E———— TRAFFIC SIGNAL ----TS-RAILROAD SIGNAL -----RR-TEL/COMM ———TEL—— FIRE ALARM ————FA——— FIBER OPTIC ———FO—— TELEVISION ————TV——— STORM DRAIN -POSSIBLE LINE LOCATION (UNK) FIRE HYDRANT METER/PULL BOX VAULT VALVE SITE LIGHT STREET LIGHT UNVERIFIED PATH - - - -GAS MANIFOLD - - -DEPTH FROM SURFACE DIA. OF PIPE NC = NOT CONNECTED


1 inch = 20 ft.





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NT = NO TONEEOS = END OF SIGNAL

FDC = FIRE DEPARTMENT CONNECTION GPR = GROUND PENETRATING RADAR LOCATED LINE

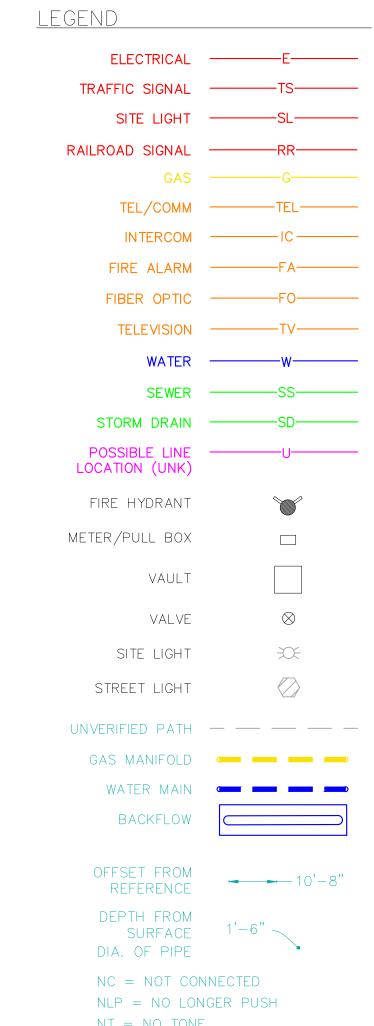



DATE LOCATED: 3/6/23

DRAWN BY/DATE: 3/17/23

TECHNICIAN
CHECK BY/DATE: AZ
CHECKED BY/DATE: HZ

SCALE: 1" = 20'

PROJECT NO: --

DATE BY DESCRIPTION

VCA ENGINEERING
FIELD AVE, SUITE 210, ALHAMBRA, CA 91801
TON COMMUNITY COLLEGE
E ARTESIA BLVD, COMPTON, CA 90221

client and/or property owner of the responsibility of having to comply with California Government Code §§4216-4216.9. It is expressly understood by the client and/or owner that Ultra ingineering services are not a charting for compliance with

EBLEY CT. WINCHESTER, CA 92596 | PHONE: 951-223-3552 | HTTP://www.Ultrasafedig.com






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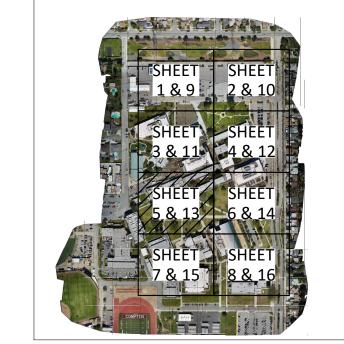
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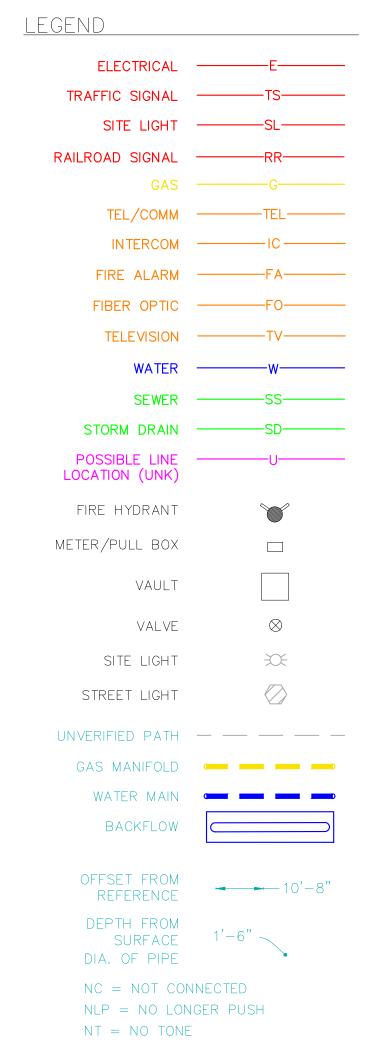
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NOTES: The services provided by Ultra Engineering do not relieve the Client and/or property owner of the responsibility of having to comply with California Government Code §\$4216-4216.9. It is expressly understood by the Client and/or owner that Ultra Engineering services are not a substitute for compliance with California Code §\$4216-4216.9.



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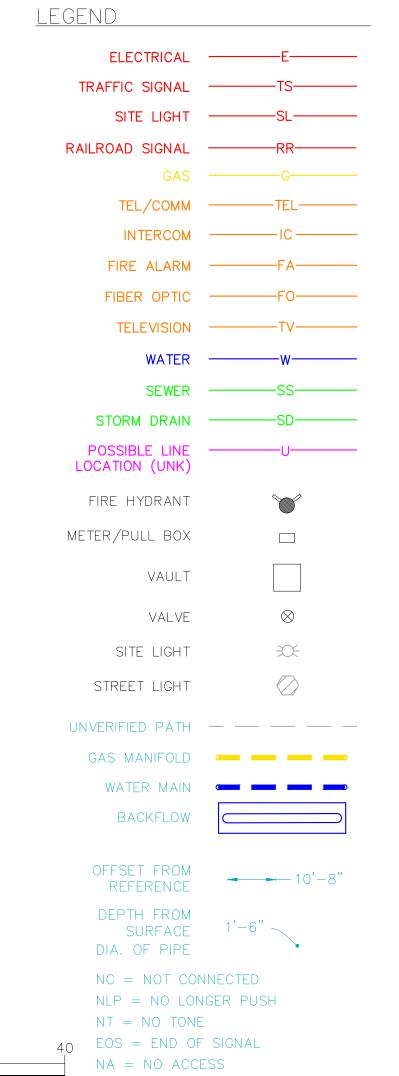


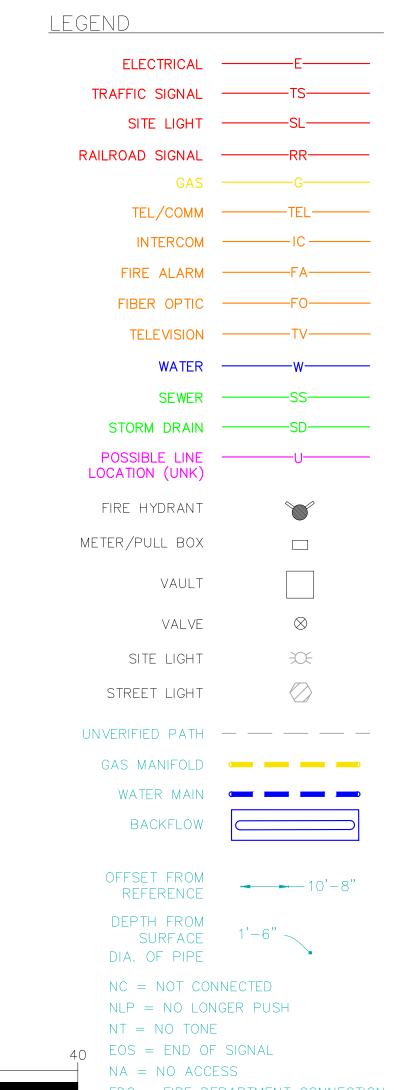

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NO DATE BY DESCRIPTION

VCA ENGINEERING

1 S GARFIELD AVE, SUITE 210, ALHAMBRA, CA 91801

COMPTON COMMUNITY COLLEGE

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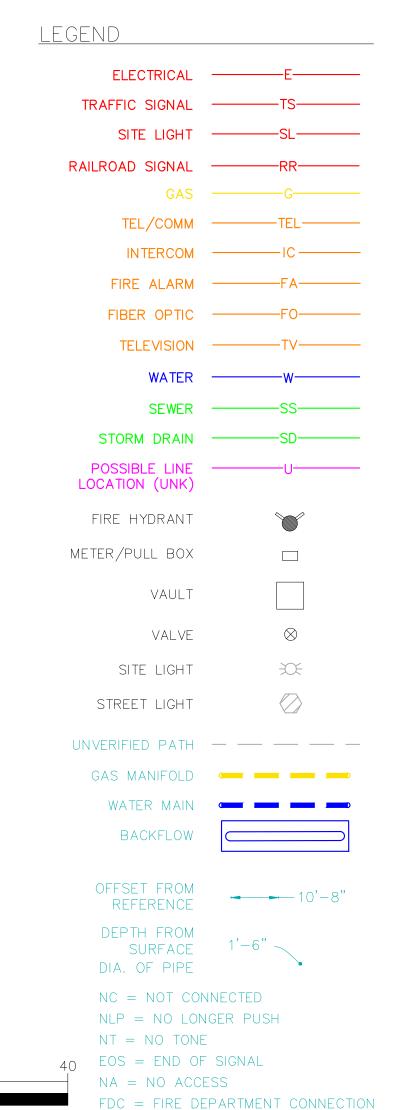
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